


COUNTY AND HIGHWAY	ROUTE AND SECTION	CLASS AND AGREEMENT		FEDERAL DIVISION OFFICE	SHEET NUMBER	TOTAL SHEETS
		STATE	FEDERAL			
				WIS.	4	

INDEX OF SHEETS



SHEET NO.	TITLE	TO STA.
1	TYPICAL CROSS SECTIONS	
2	ESTIMATE OF QUANTITIES	
3	MISCELLANEOUS QUANTITIES	
4	RIGHT OF WAY PLAT	
5	PLAN AND PROFILE STA.	
6	STANDARD DETAILS	
7	DRAINAGE STRUCTURES	
8	CROSS SECTIONS	

STATE OF WISCONSIN
STATE HIGHWAY COMMISSION OF WISCONSIN

PLAN AND PROFILE OF PROPOSED

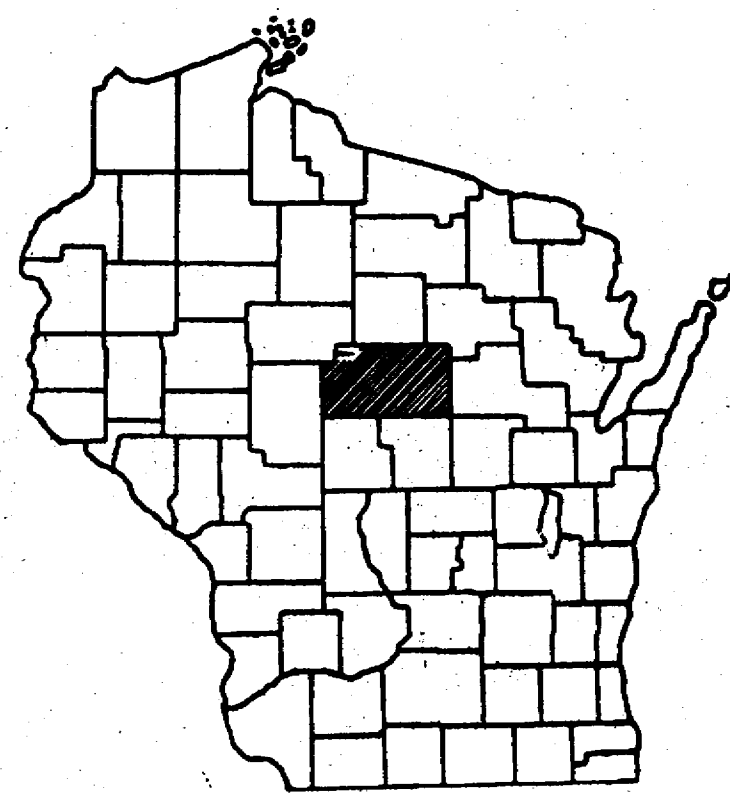

SCALES
 PLAN 1 IN. = 100 FT.
 PROFILE HOR. 1 IN. = 100 FT. VERT. 1 IN. = 10 FT.
 CROSS SECTIONS HOR. 1 IN. = 5 FT. VERT. 1 IN. = 5 FT.

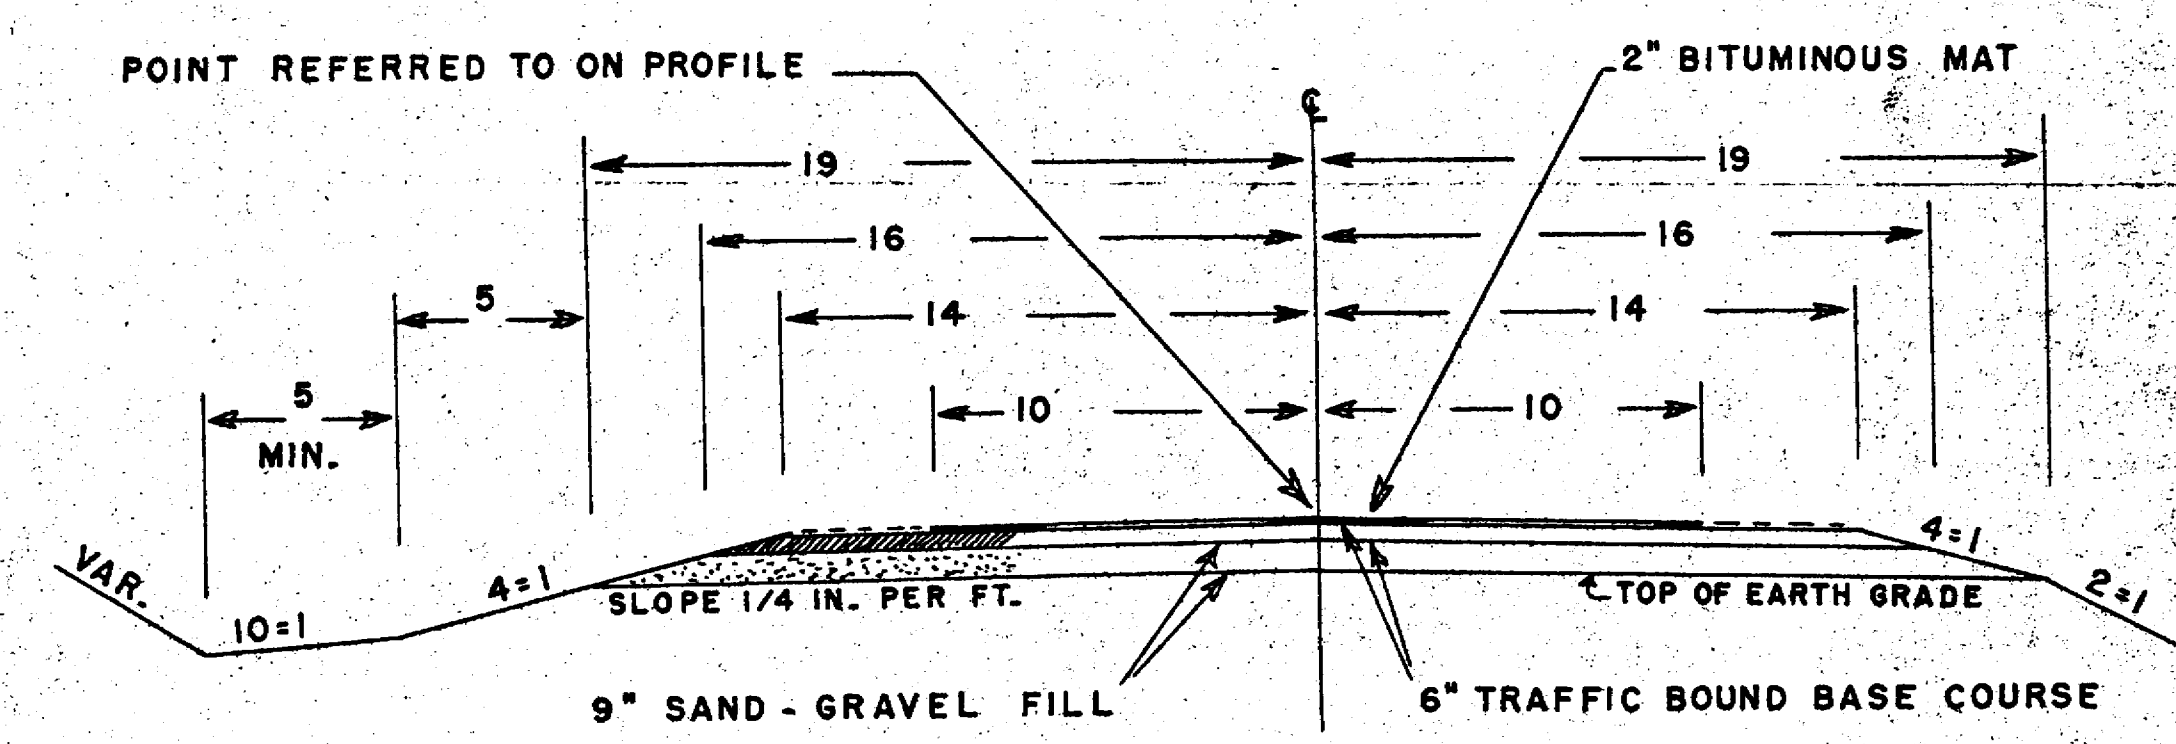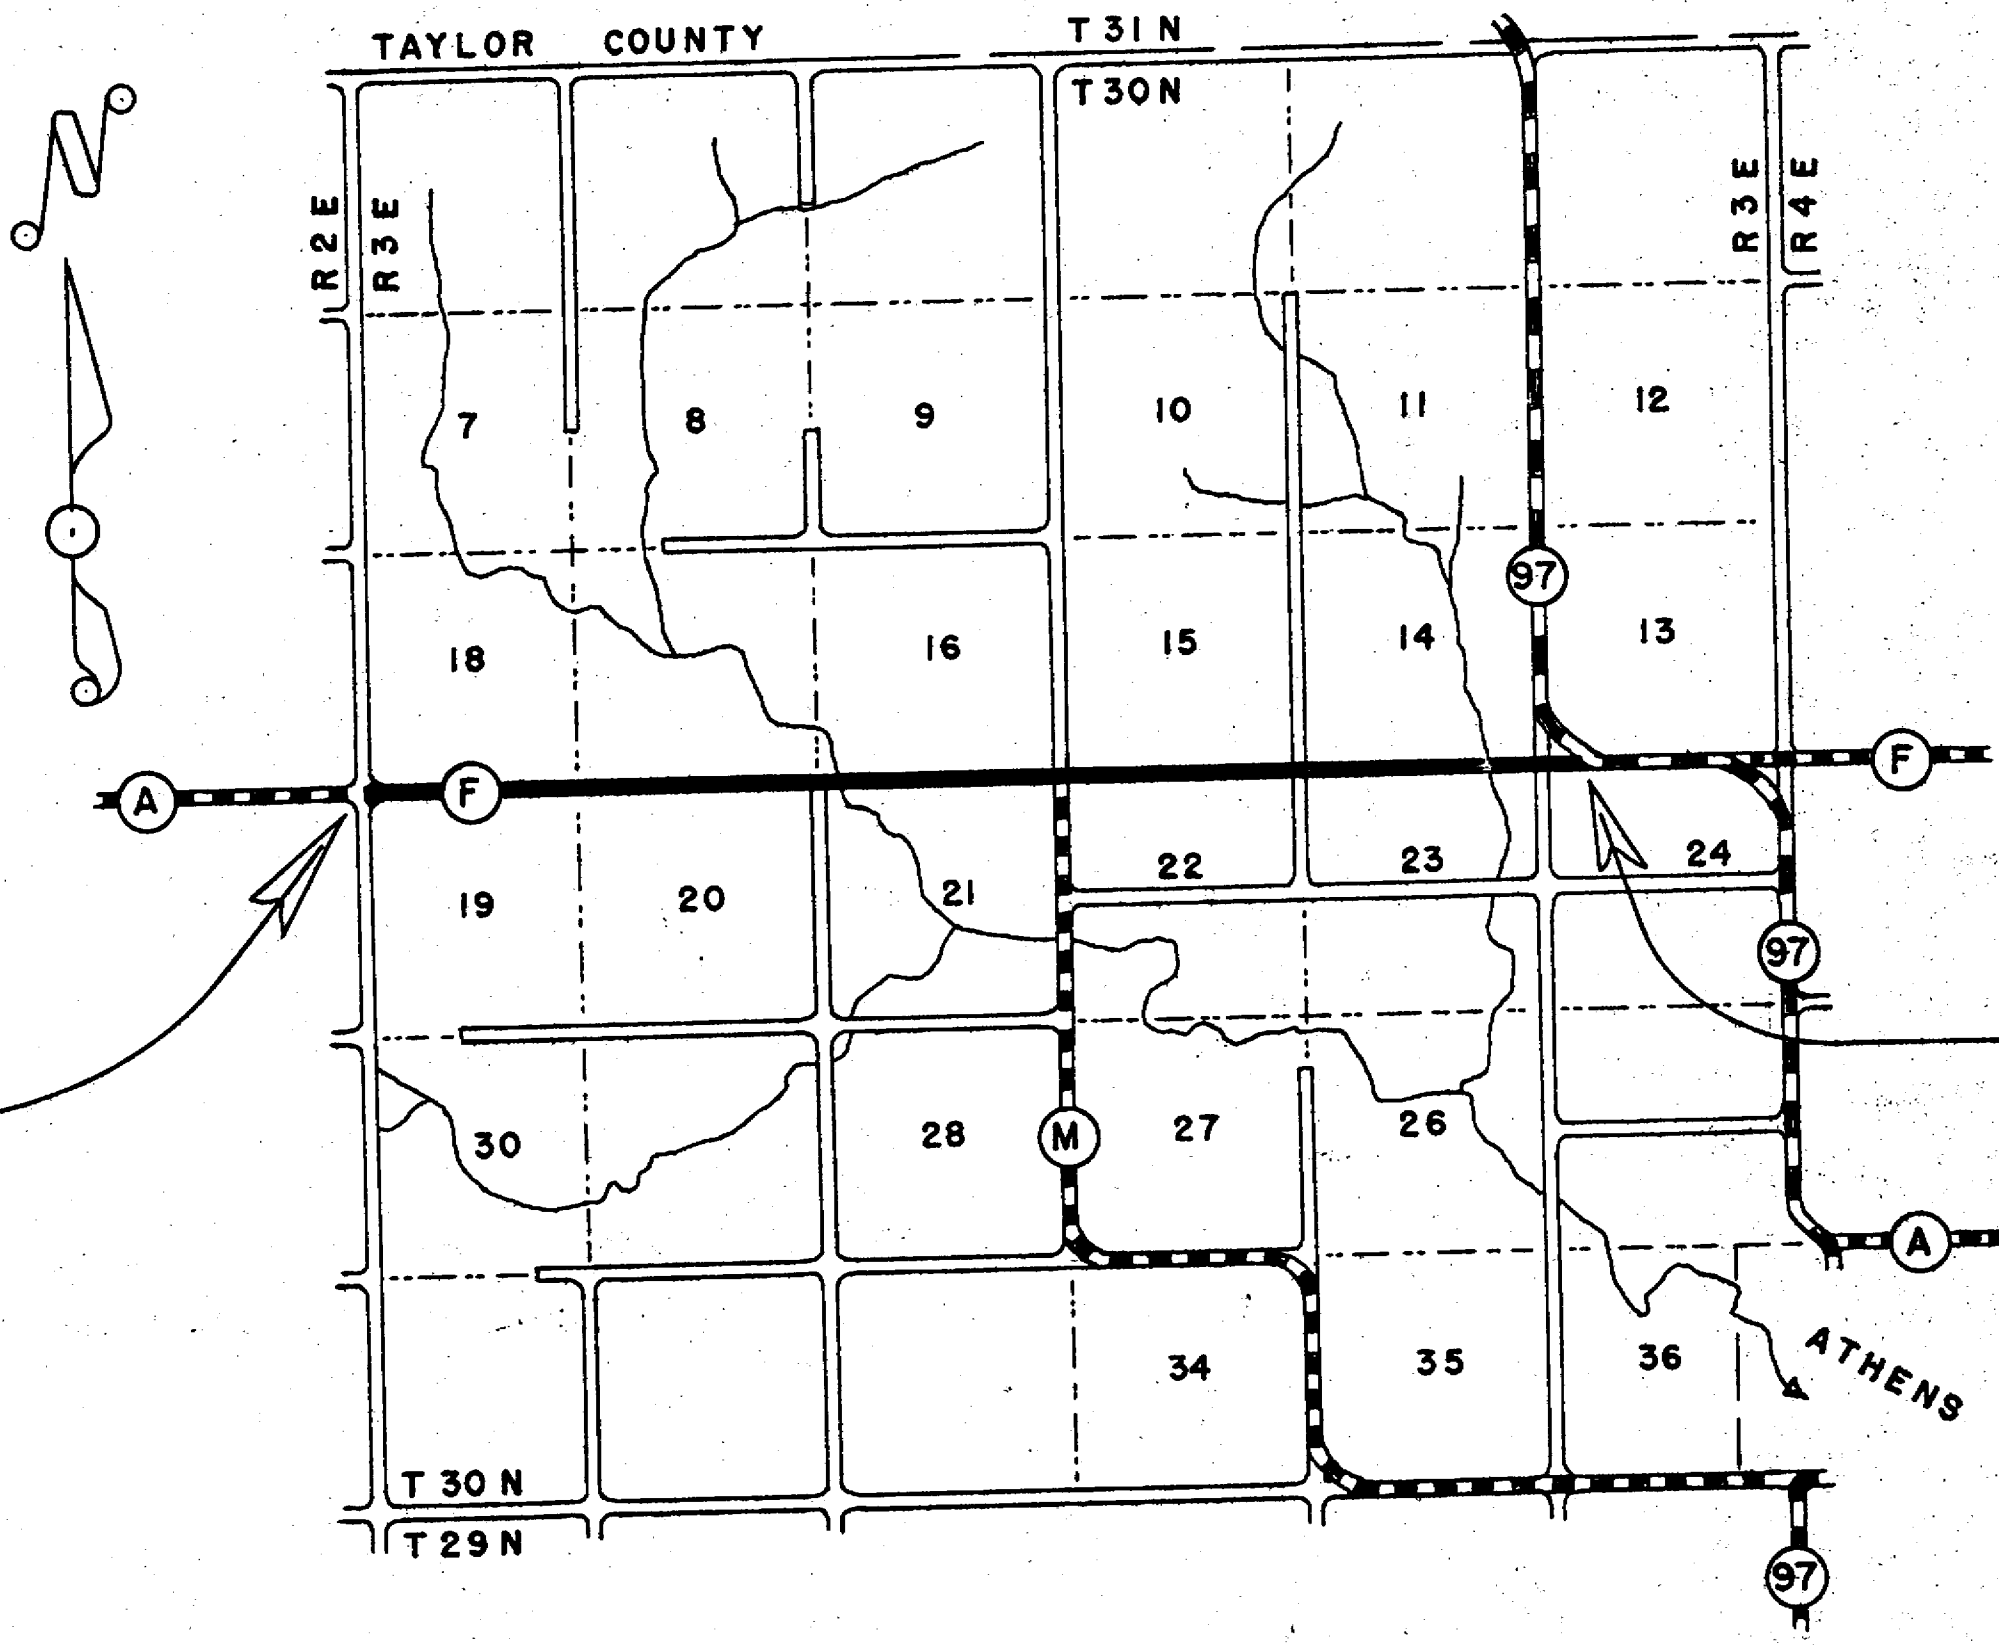

BEGINNING OF PROJECT
 STA. 0+00.0 = END OF PROJECT S 0592
 = SW COR. SEC. 18

END OF PROJECT
 STA. 260+42.5 = EDGE OF BLACKTOP PROJECT S 015 5
 700.4' E. OF SE COR. SEC. 14

CONVENTIONAL SIGNS

STATE LINE.....	CULVERTS IN PLACE.....
COUNTY LINE.....	CULVERTS REQUIRED.....
TOWNSHIP OR RANGE LINE.....	DROP INLET.....
SECTION LINE.....	POWER POLE.....
NEW RIGHT OF WAY LINE.....	TELEPHONE OR TELEGRAPH POLE.....
PRESENT RIGHT OF WAY LINE.....	RIGHT OF WAY MARKERS.....
WIRE FENCE { WOVEN.....	REFERENCE STAKE FOR HUBS ONLY.....
{ BARBED.....	MARSH.....
LOT LINE.....	HEDGE.....
CORPORATE OR CITY LIMITS.....	TREES.....
PROPERTY LINE.....	GROUND ELEVATION..... DATUM LINE 73.16 73.19
TRAVELED WAY OR P.E.....	GRADE ELEVATION..... DATUM LINE 73.16 73.19
RAILROADS.....	
BASE OR SURVEY LINE.....	


LAYOUT
 SCALE 1" = ONE MILE
 TOTAL NET LENGTH OF CENTERLINE = 4.932 MI.

STATE HIGHWAY COMMISSION OF WISCONSIN MADISON, WISCONSIN	
SURVEYOR..... C. E. C.	NOTE BOOK..... M-72
DISTRICT COMPUTER..... CAL	M. O. CHECKER.....
DISTRICT CHECKER.....	CORRECT.....
CORRECT.....	
DATE.....	DISTRICT ENGINEER.....
RECOMMENDED FOR APPROVAL:	
DATE.....	ENGINEER OF DESIGN.....
APPROVED:	
DATE.....	STATE HIGHWAY ENGINEER.....
DEPARTMENT OF COMMERCE BUREAU OF PUBLIC ROADS	
APPROVED:	
	DATE.....
	DISTRICT ENGINEER.....

C.T.H. "F" - BERN

BENCH MARKS			
1	0+81	SPIKE IN 12" MAPLE	45' R 500.00
2	18+74	" " " 6"	45' R 506.46
3	46+11	" " " 8" ELM	60' R 507.81

E.P.R. DIVISION	PROJECT	SHEET NUMBER	TOTAL SHEETS
4			

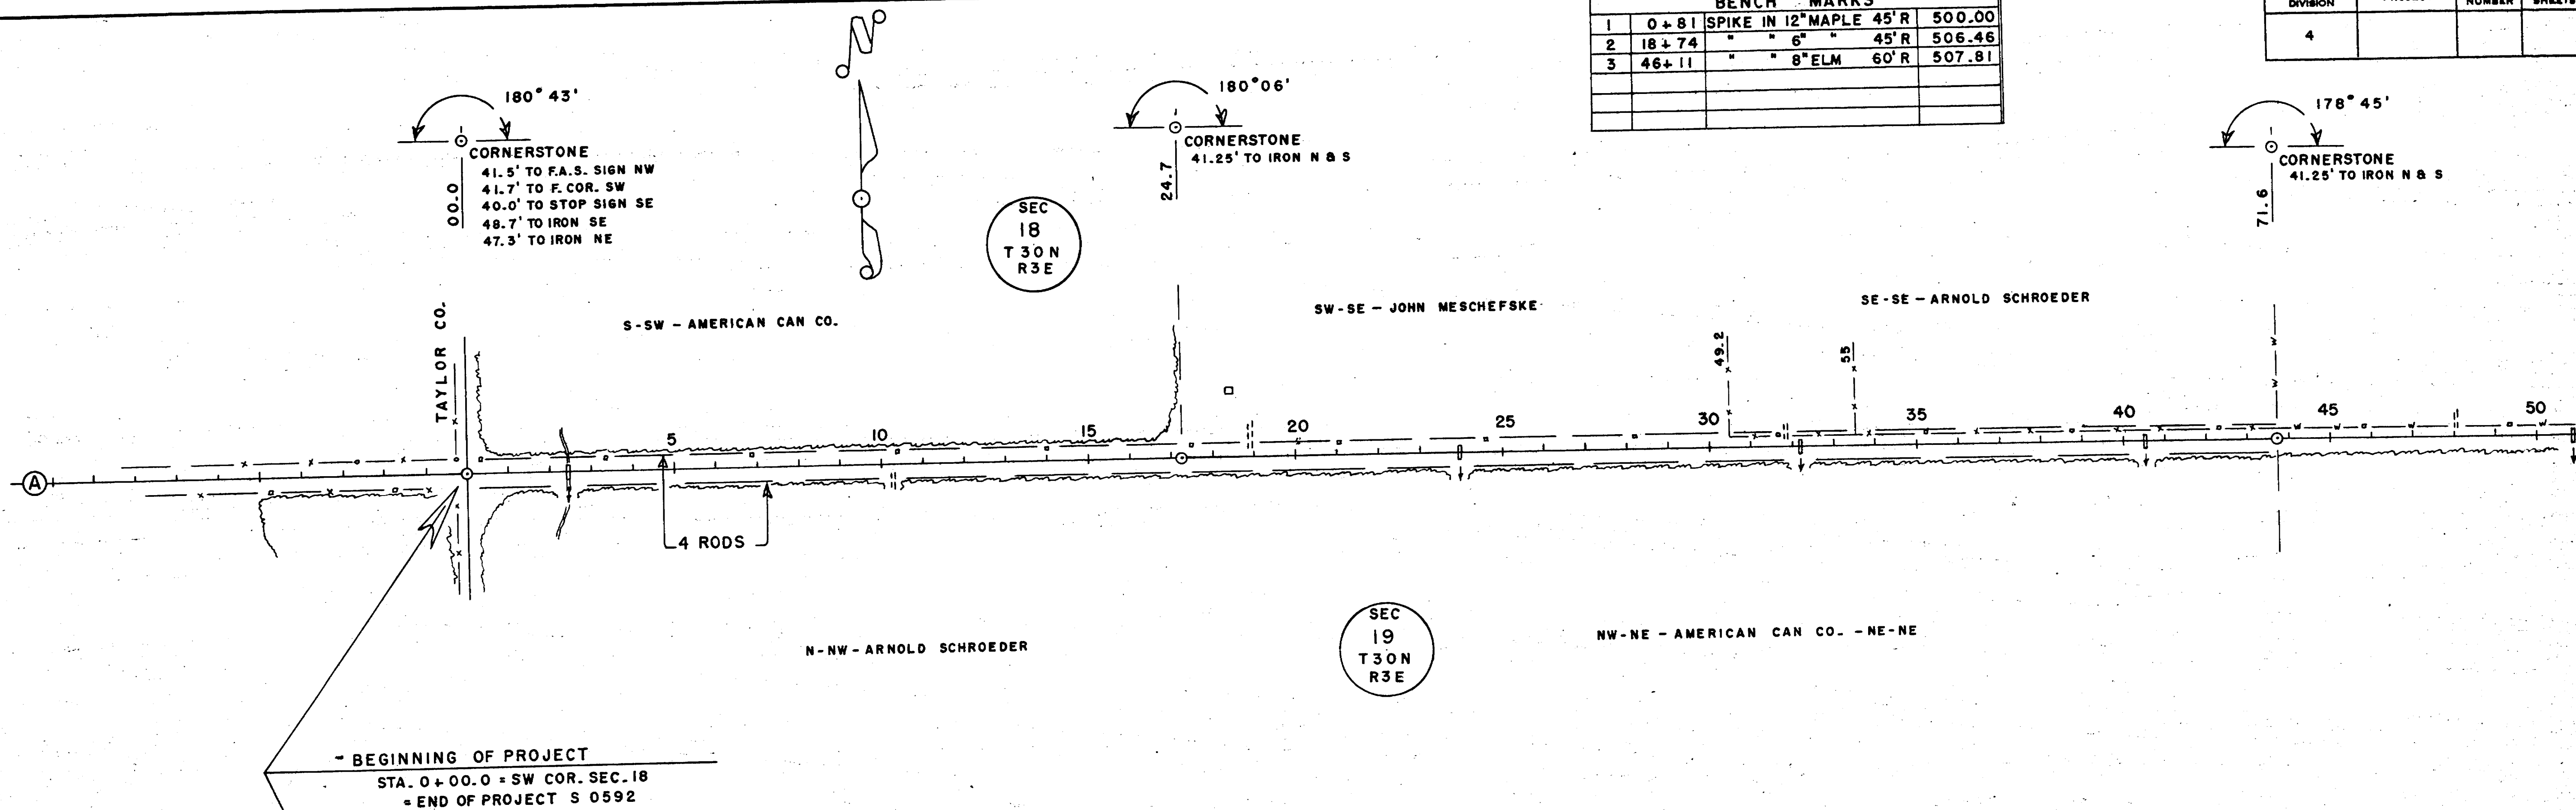

NET LENGTH OF \bar{C} STA. 0+00.0 TO STA. 43+71.6 = 4,371.6 LINEAL FT. R/W = 4 RODS - BERN RECORDS A-141

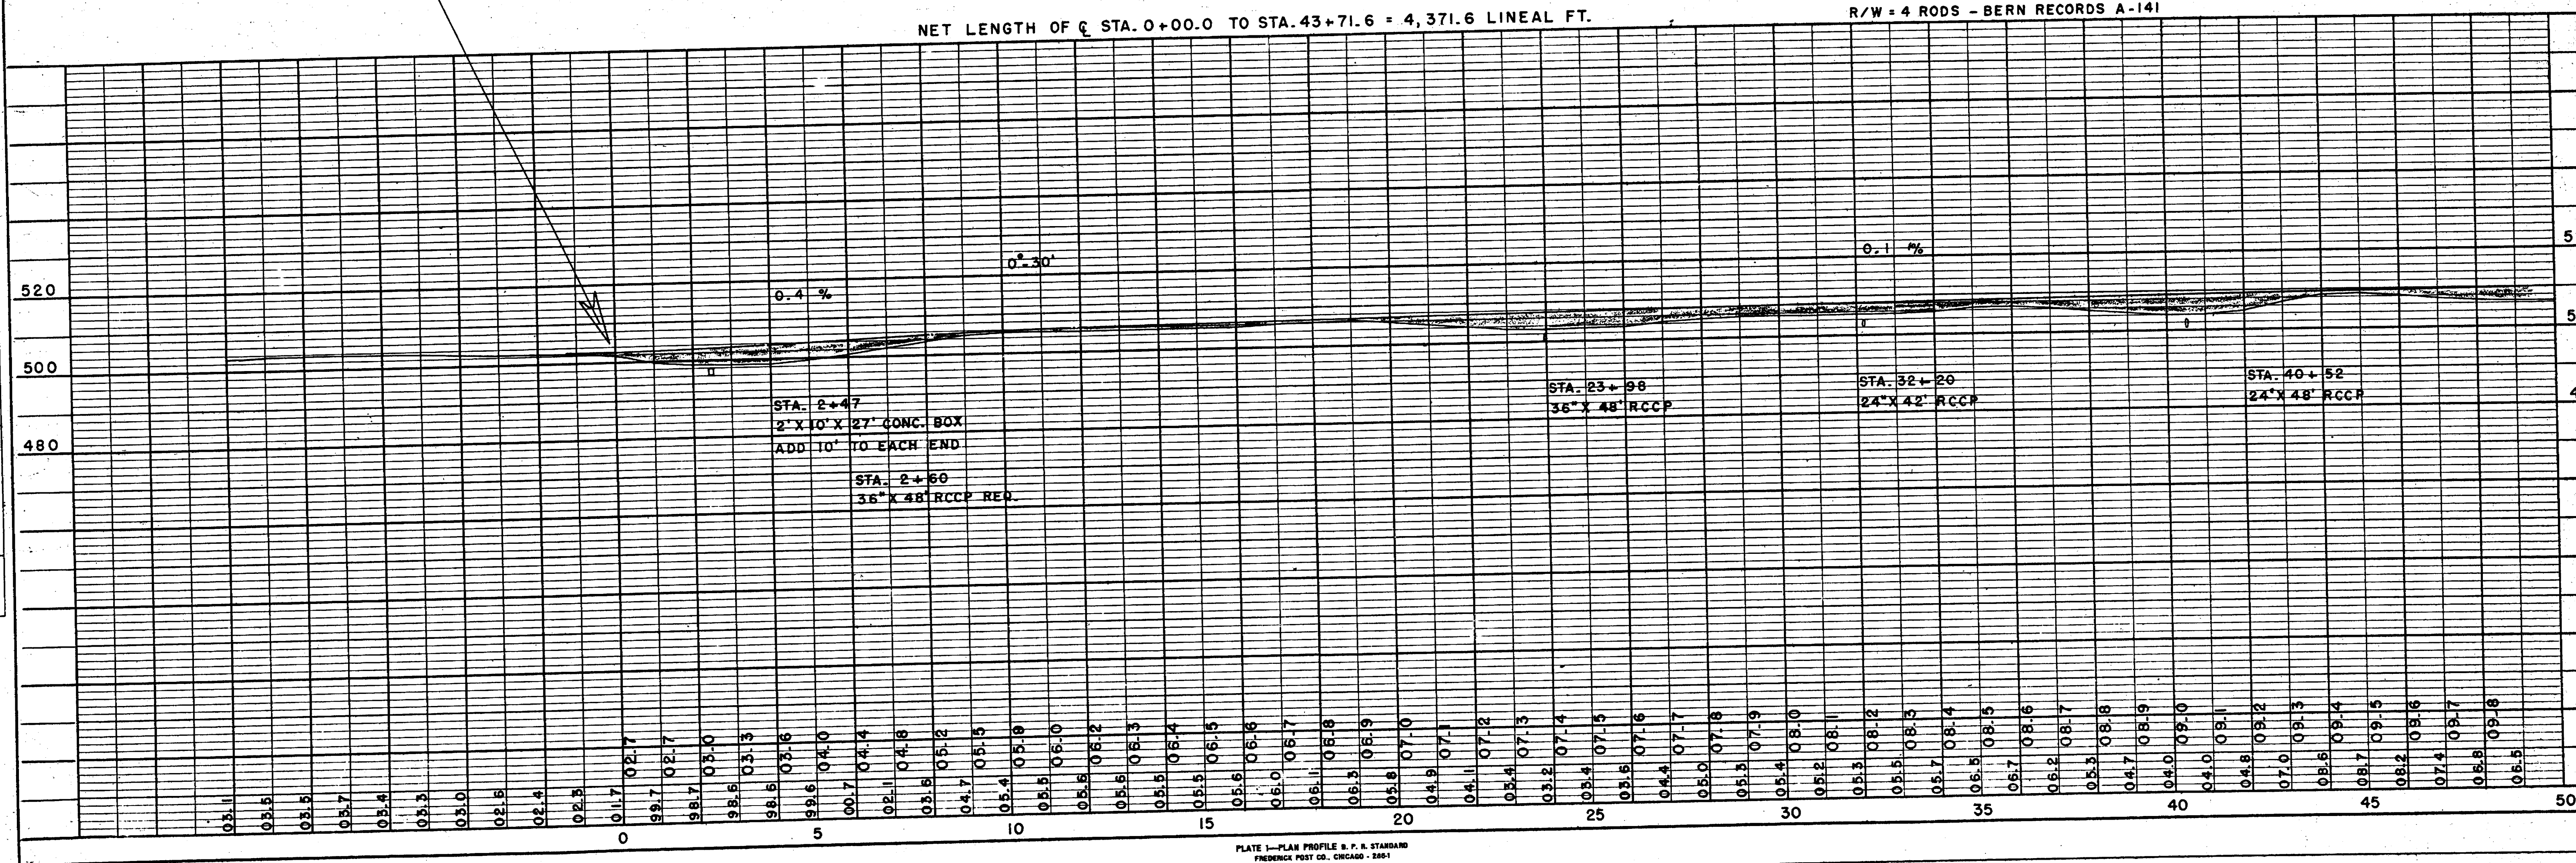



PLATE 1—PLAN PROFILE & P. R. STANDARD
FRANKLIN POST CO. CHICAGO 1961

PLANS CHECKED
 BY: []
 DATE: []
 NOTE BOOK NO. []

NOTES CHECKED
 BY: []
 DATE: []
 STRUCTURE NOTES CHECKED
 BY: []
 DATE: []


BENCH MARKS				
3	46+11	SPIKE IN 8" ELM	60'R	507.81
4	60+56	" " 10" ASH	55'R	507.31
5	66+88	" " 5" SPRUCE	45'R	517.26
6	83+72	" " 5" ELM	45'R	493.96
7	97+48	" " 12" ELM	60'L	468.67

D.P.R. DIVISION	PROJECT	SHEET NUMBER	TOTAL SHEETS
4			

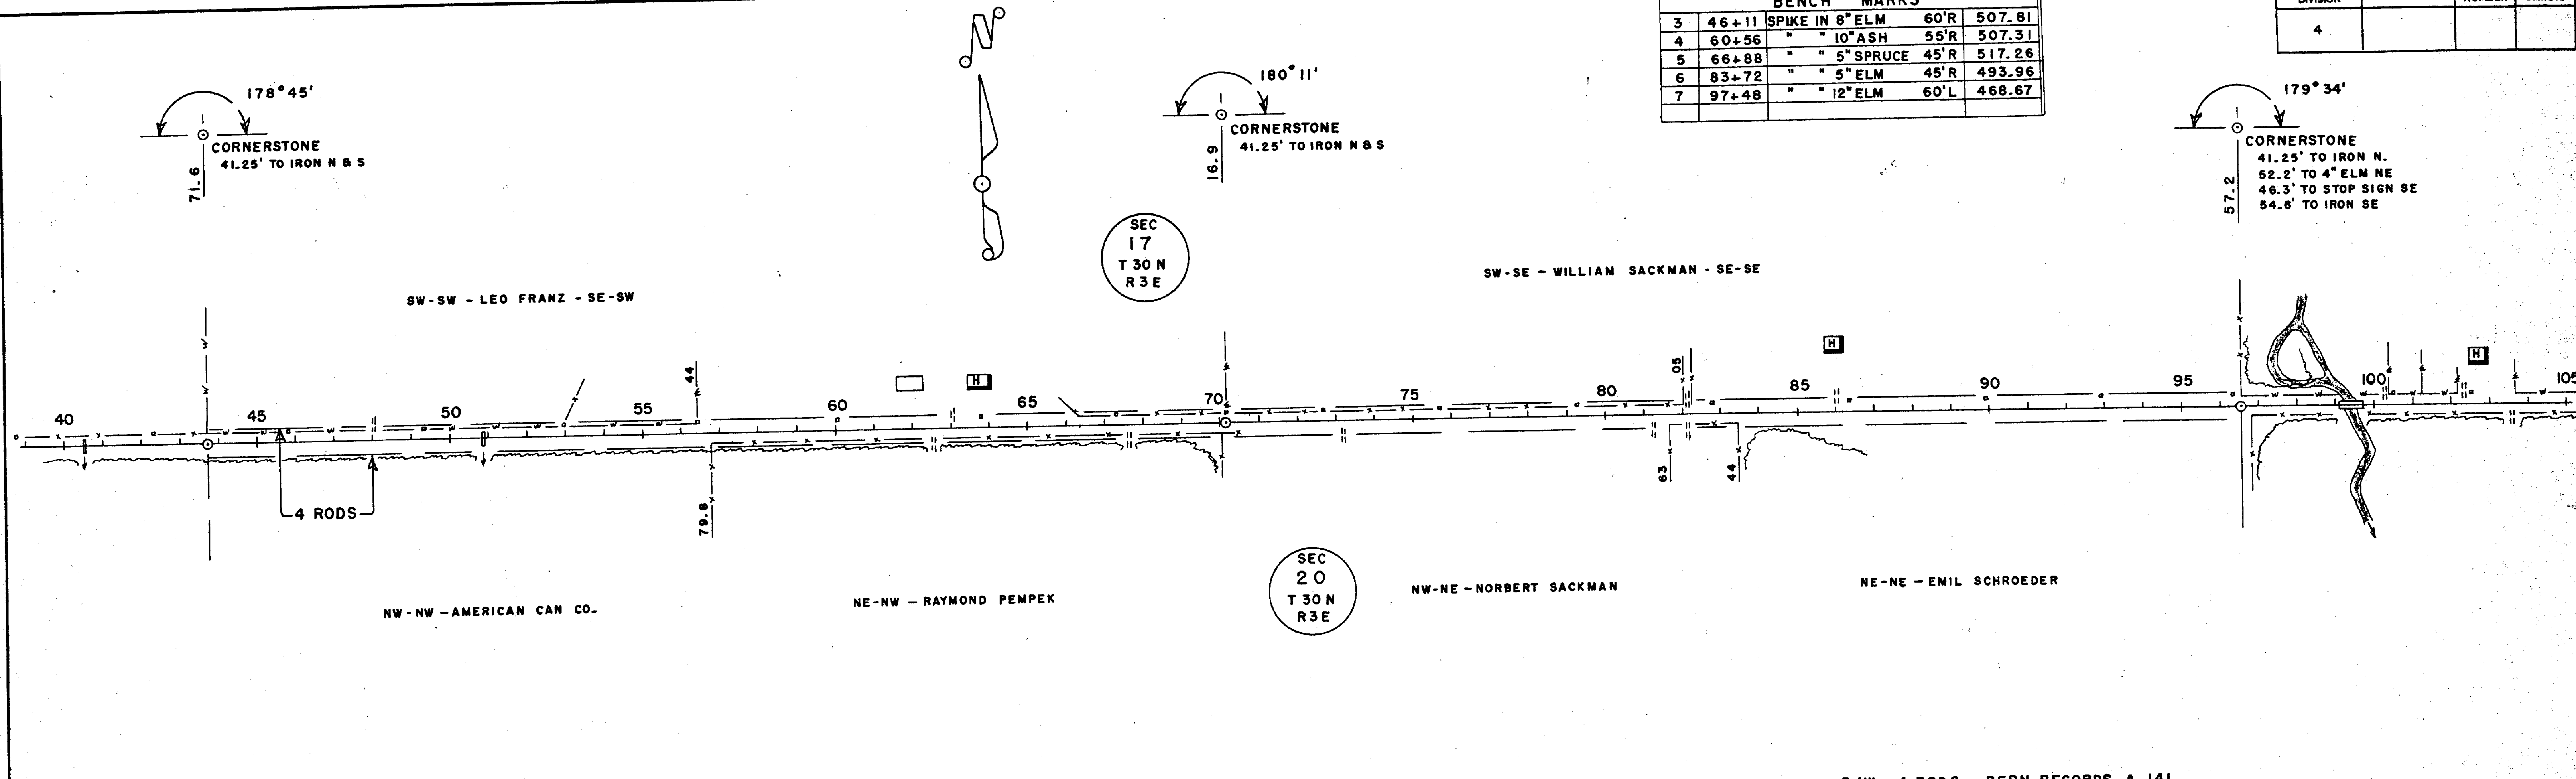

NET LENGTH OF C STA. 43+71.6 TO STA. 96+57.2 = 5,285.7 LINEAL FT.

R/W = 4 RODS - BERN RECORDS A-141



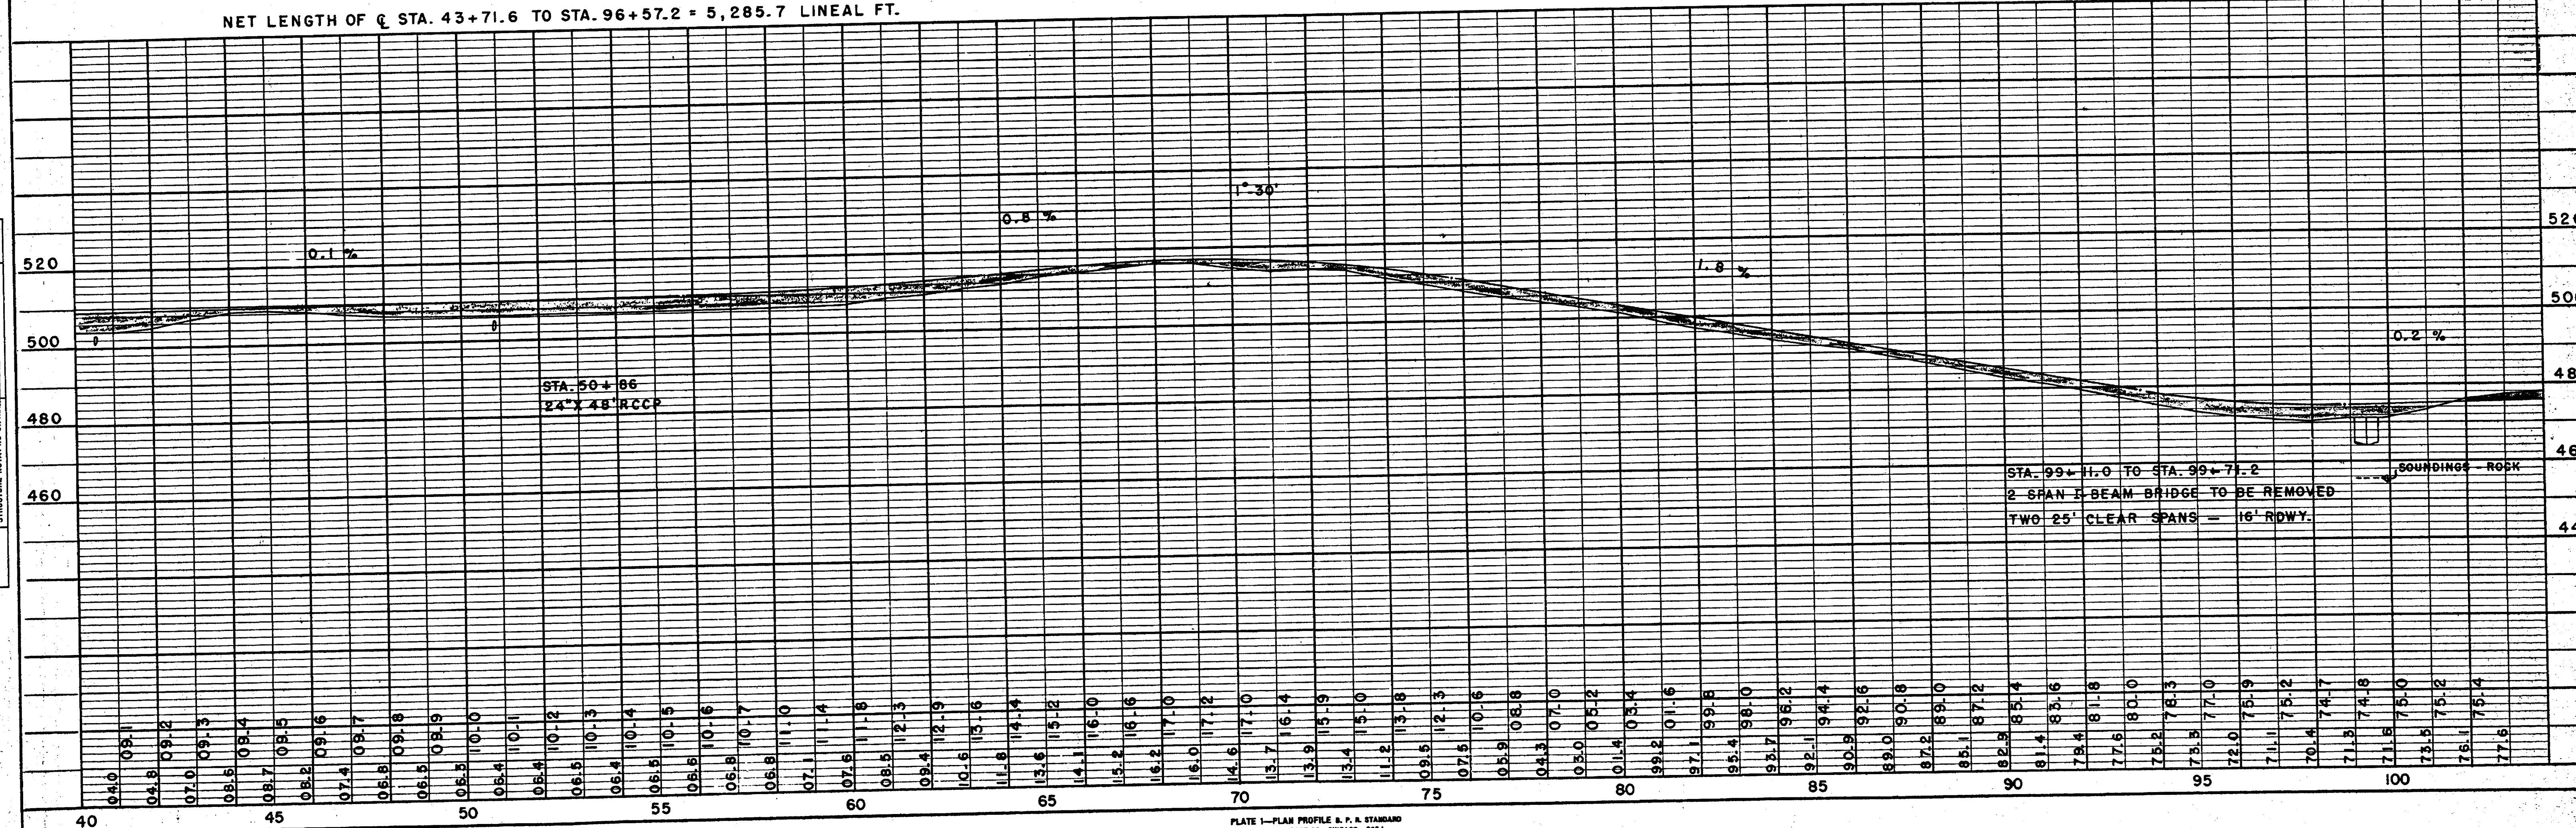


NOTE BOOK ALIGNMENT CHECKED
RT. OF WAY CHECKED
NO.

NOTE BOOK GRADES CHECKED
P. A. S. NOTED
STRUCTURE STATUSES CHKD.
NO.

BENCH MARKS				
7	97+48	SPIKE IN 12" ELM	60'L	468.67
8	113+21	" " 10" ELM	70'R	472.49
9	121+57	" " 10" ASH	65'R	481.65
10	147+73	" " 18" ELM	40'R	505.09

B.P.R. DIVISION	PROJECT	SHEET NUMBER	TOTAL SHEETS
4			

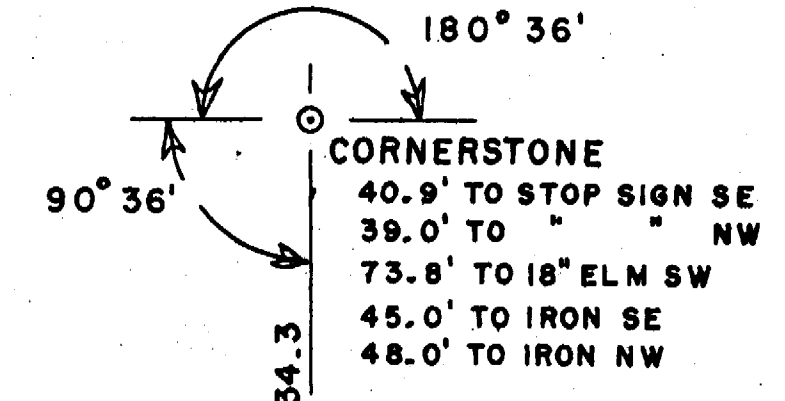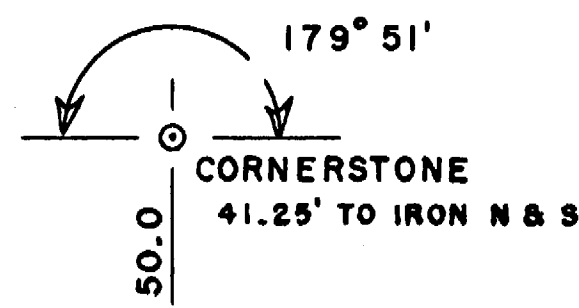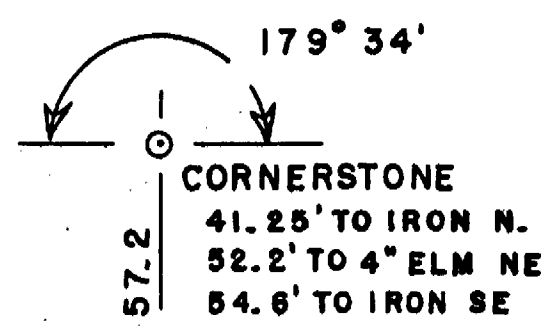

SEC 16
T 30 N
R 3E

SEC 21
T 30 N
R 3E


SW-SW - CLARENCE OLSON

SE-SW - EMIL SCHROEDER

SW-SE - WILLIAM WEILER - SE-SE


NW-NW - ELMER KORNACK - NE-NW

NW-NE - RUDY HADERLEIN - NE-NE

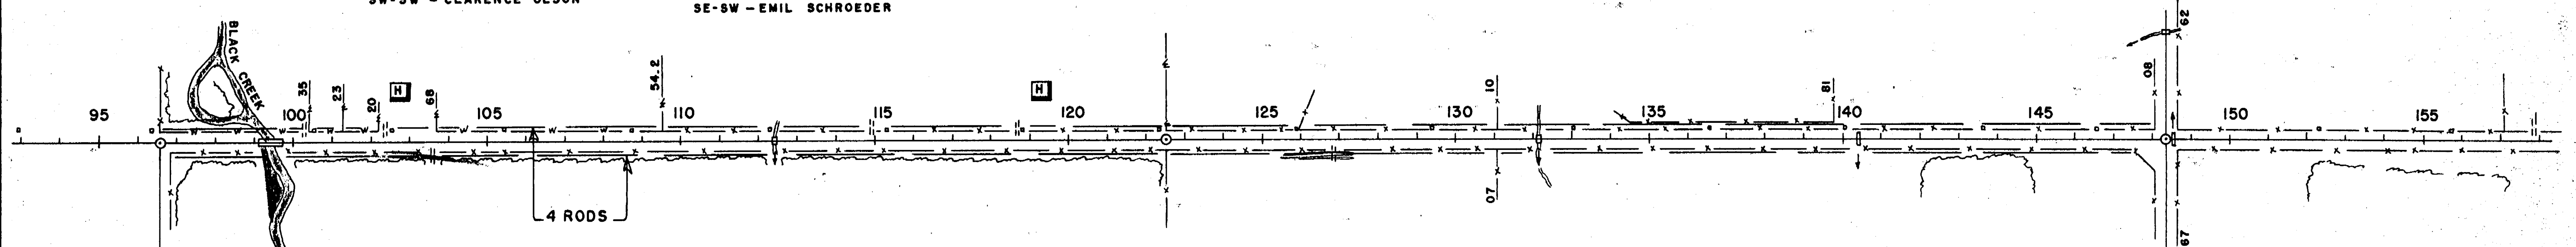

NET LENGTH OF C STA. 96+57.2 TO STA. 148+34.3 = 5,177.1 LINEAL FT.

R/W = 4 RODS - BERN RECORDS A-125

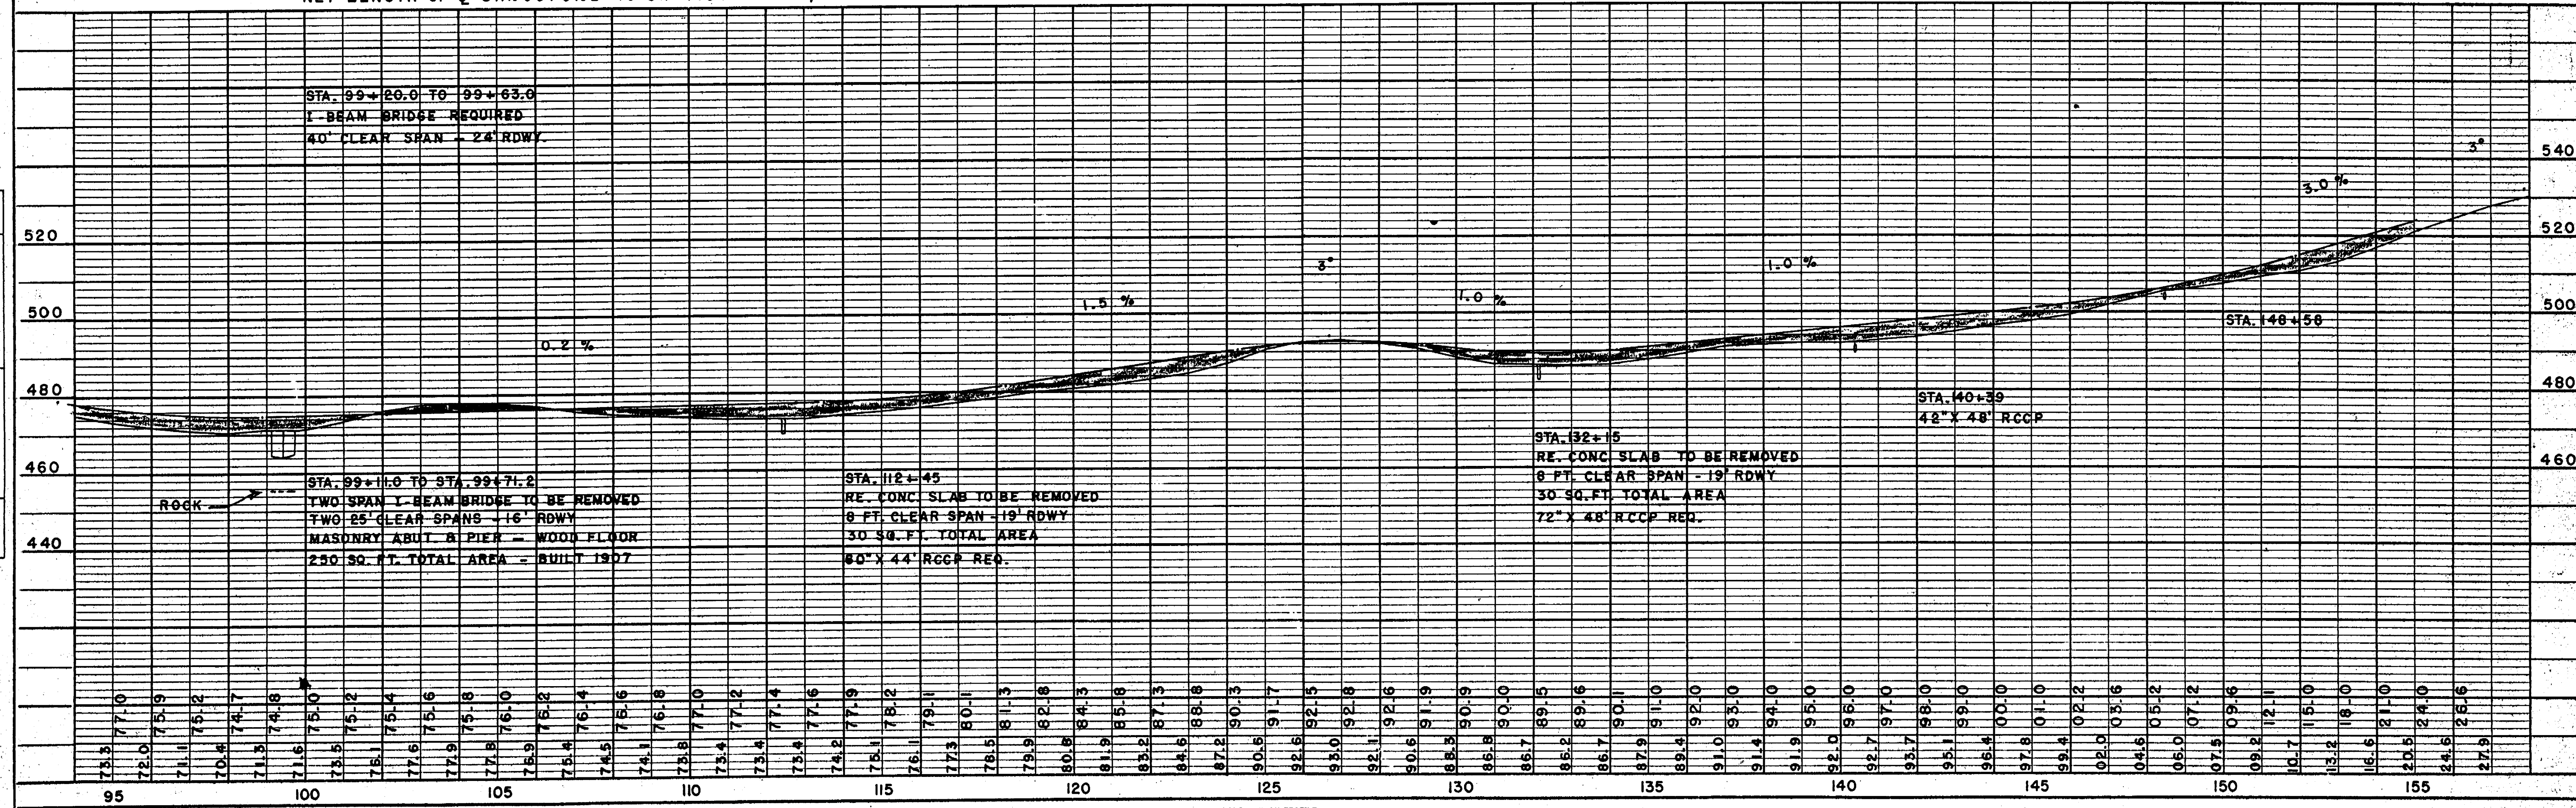


NOTE BOOK ALIGNMENT CHECKED BY RT. OF WAY CHECKED NO.

SCALE 1" = 20' GRADES CHECKED BY R. W. METER STRUCTURE NOTATION CHECKED NO.


BENCH MARKS			
10	147+73	SPIKE IN 18" ELM	40'R 505.09
11	161+91	" " 18" ELM	95'R 526.58
12	174+35	" " 12" ELM	75'R 523.98
13	200+66	" " 12" ELM	40'R 517.15

S.P.R. DIVISION	PROJECT	SHEET NUMBER	TOTAL SHEETS
4			

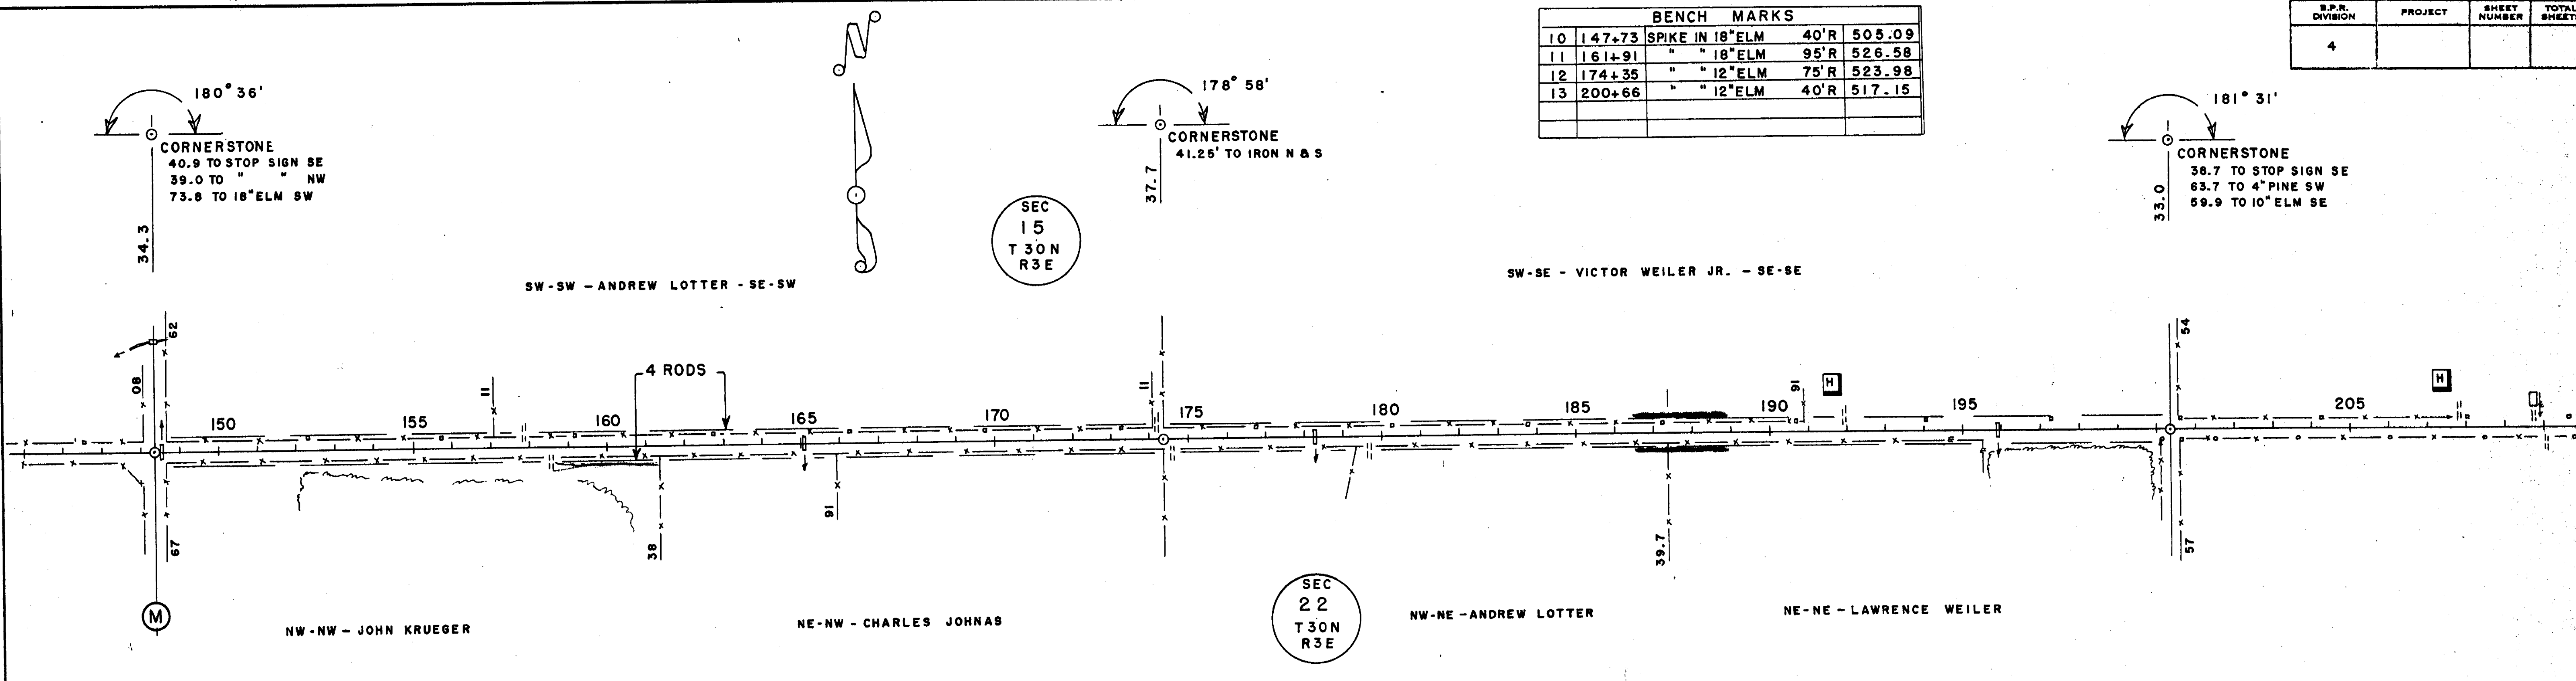

NET LENGTH OF C STA. 148+34.3 TO STA. 200+33.0 = 5,198.7 LINEAL FT.

R/W = 4 RODS - BERN RECORDS A-219

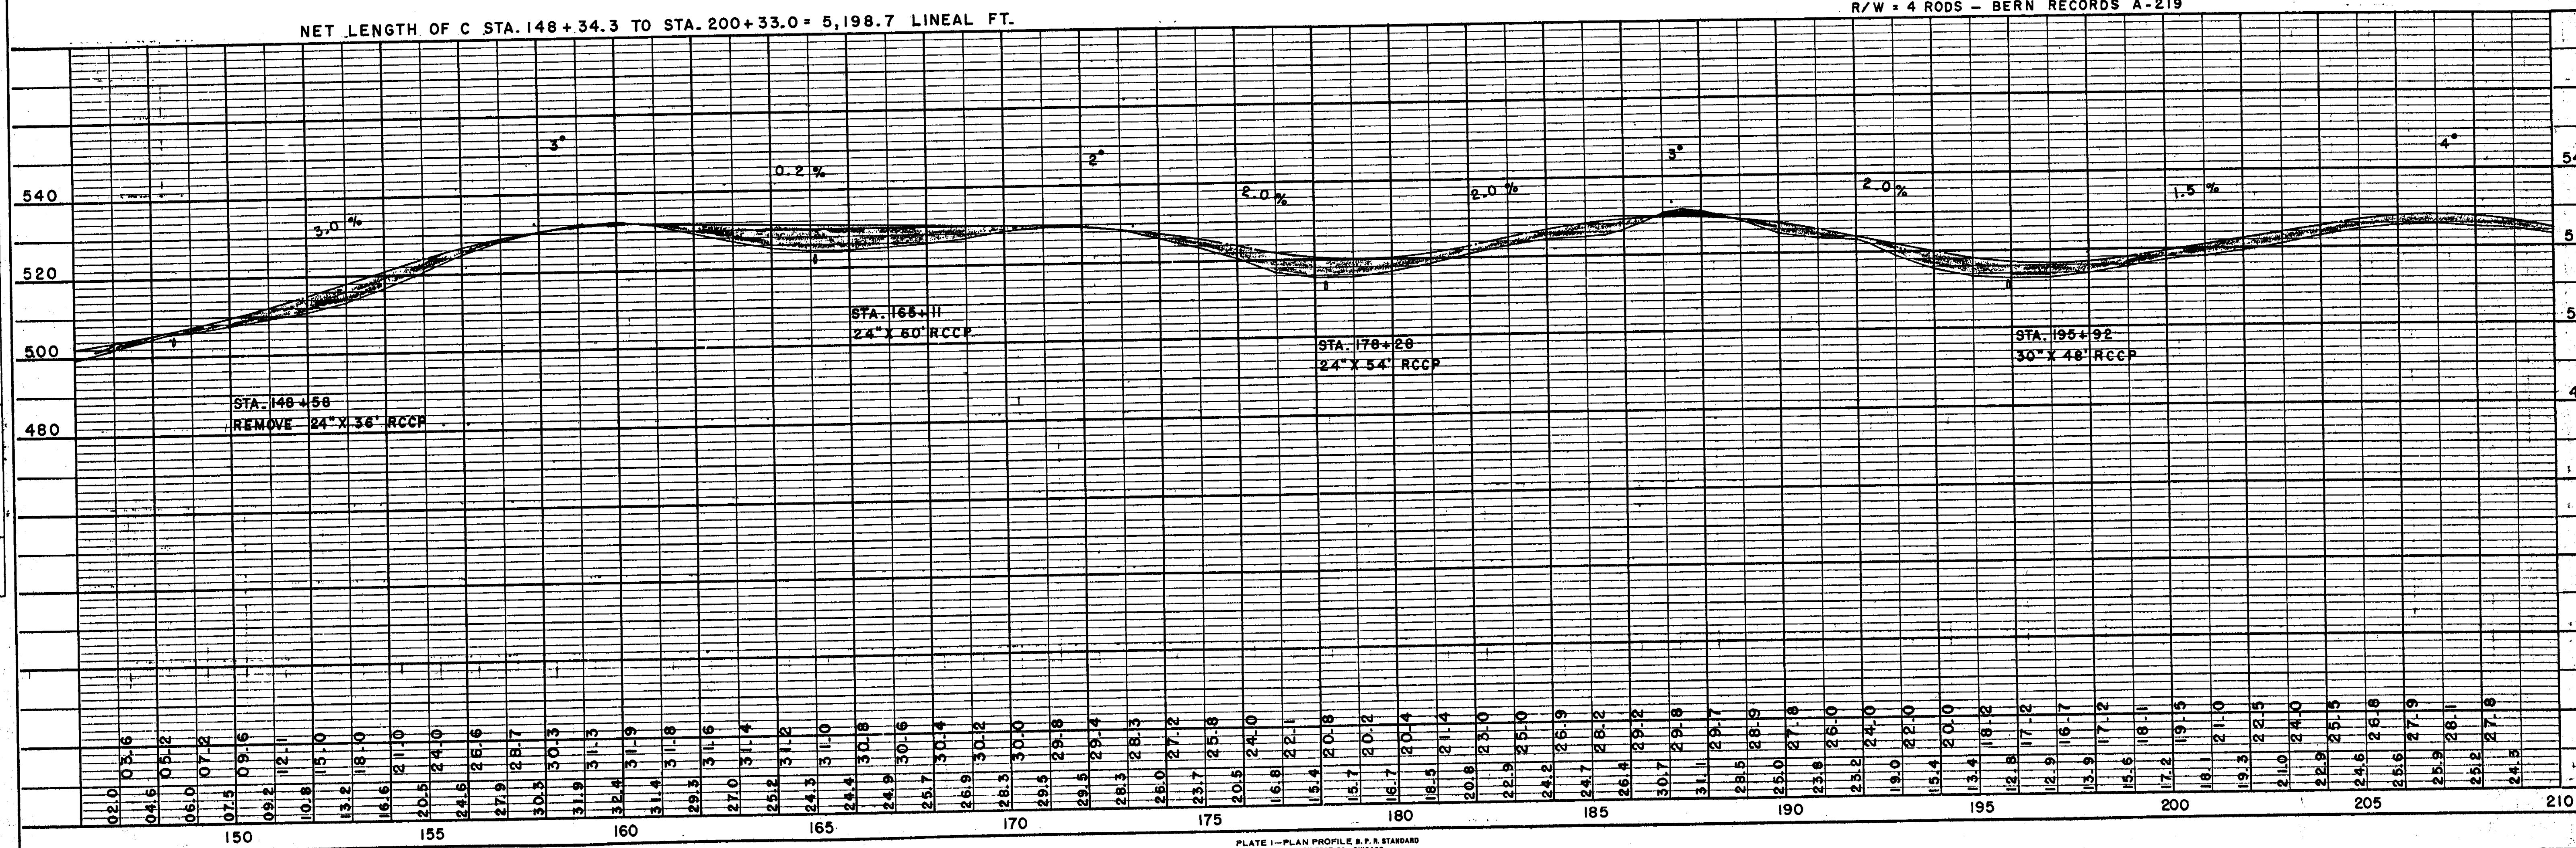


NOTE BOOK ALIGNMENT CHECKED
RT. OF WAY CHECKED

NOTE BOOK GRADES CHECKED
R. B.'S INTERVIEWS
STATIONING INTERVIEWS OK'D.


BENCH MARKS			
13	200+66	SPIKE IN 12" ELM	40'R 517.15
14	213+68	" 10" ELM	45'R 511.52
15	230+26	" 10" ASH	60'L 468.24
16	243+60	" 6" ELM	70'L 447.98
17	251+93	" 12" PINE	75'L 468.49
18	260+25	" POW. POLE	35'R 492.30

B.P.R. DIVISION	PROJECT	SHEET NUMBER	TOTAL SHEETS
4			

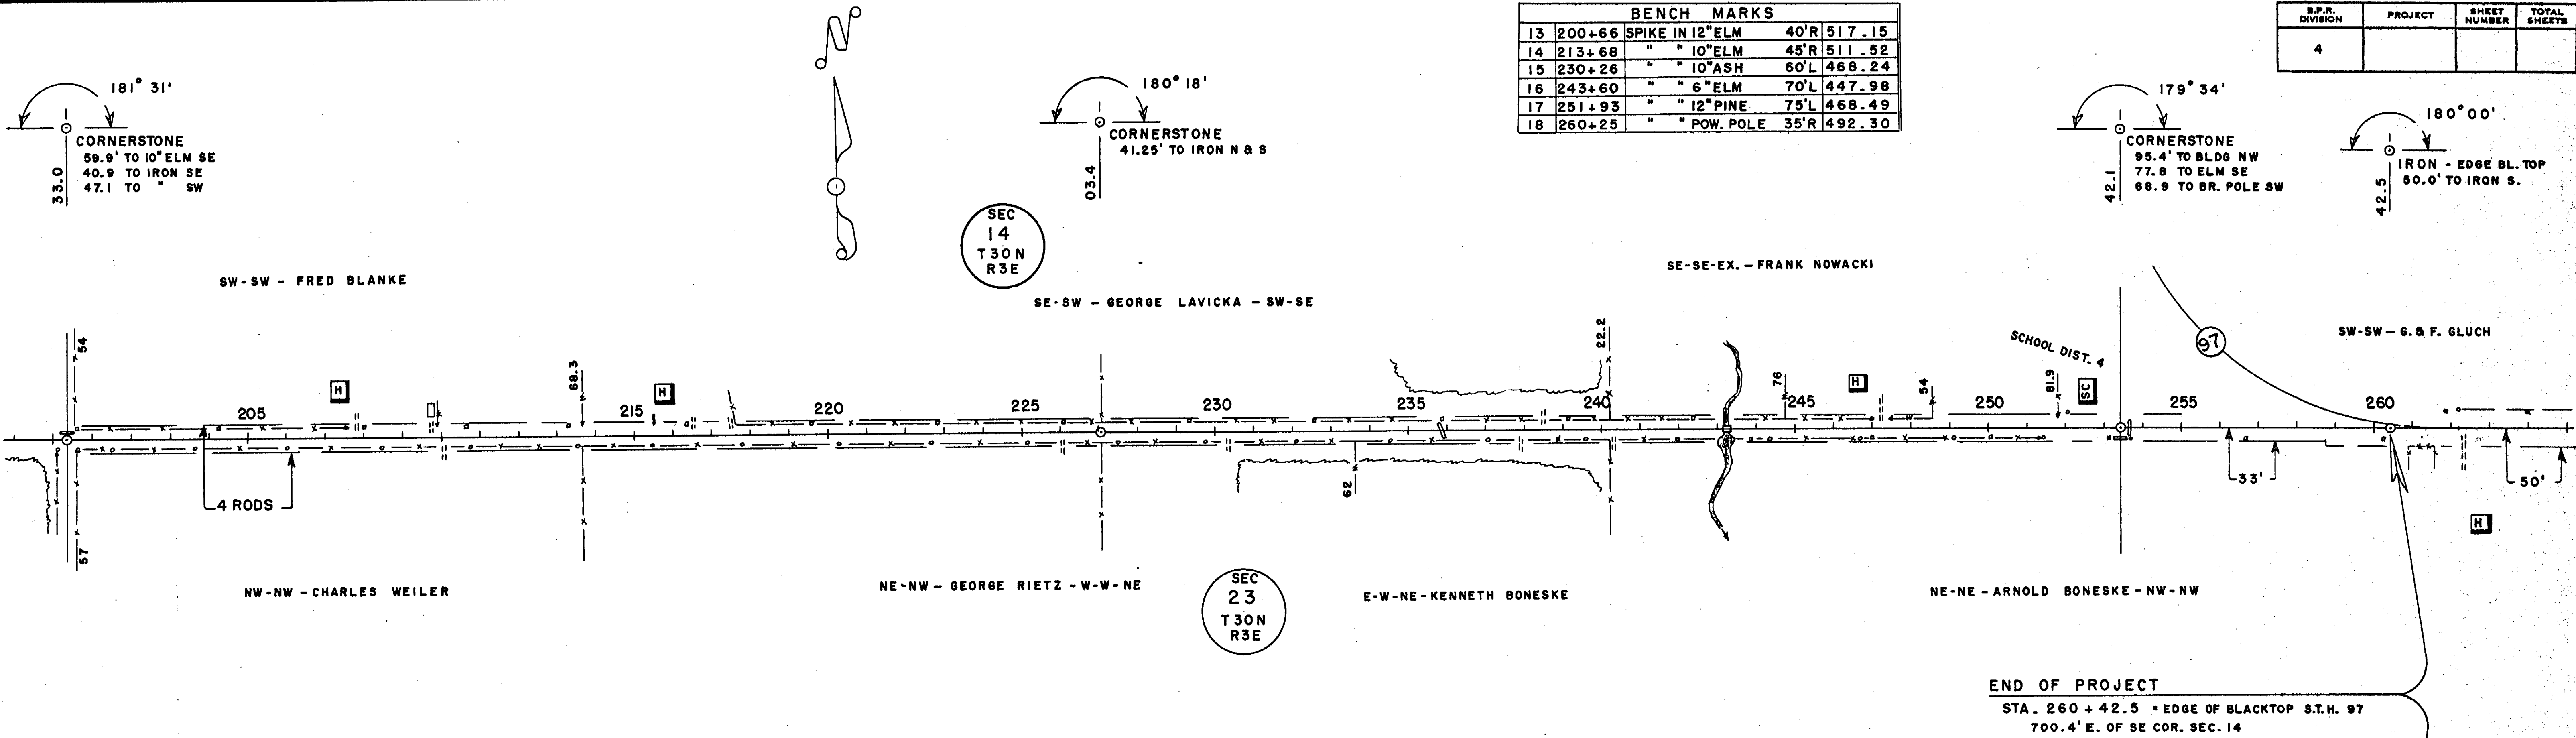

NET LENGTH OF C STA. 200+33.0 TO STA. 260+42.5 = 6,009.5 LINEAL FT.

R/W = 4 RODS - BERN RECORDS A-20

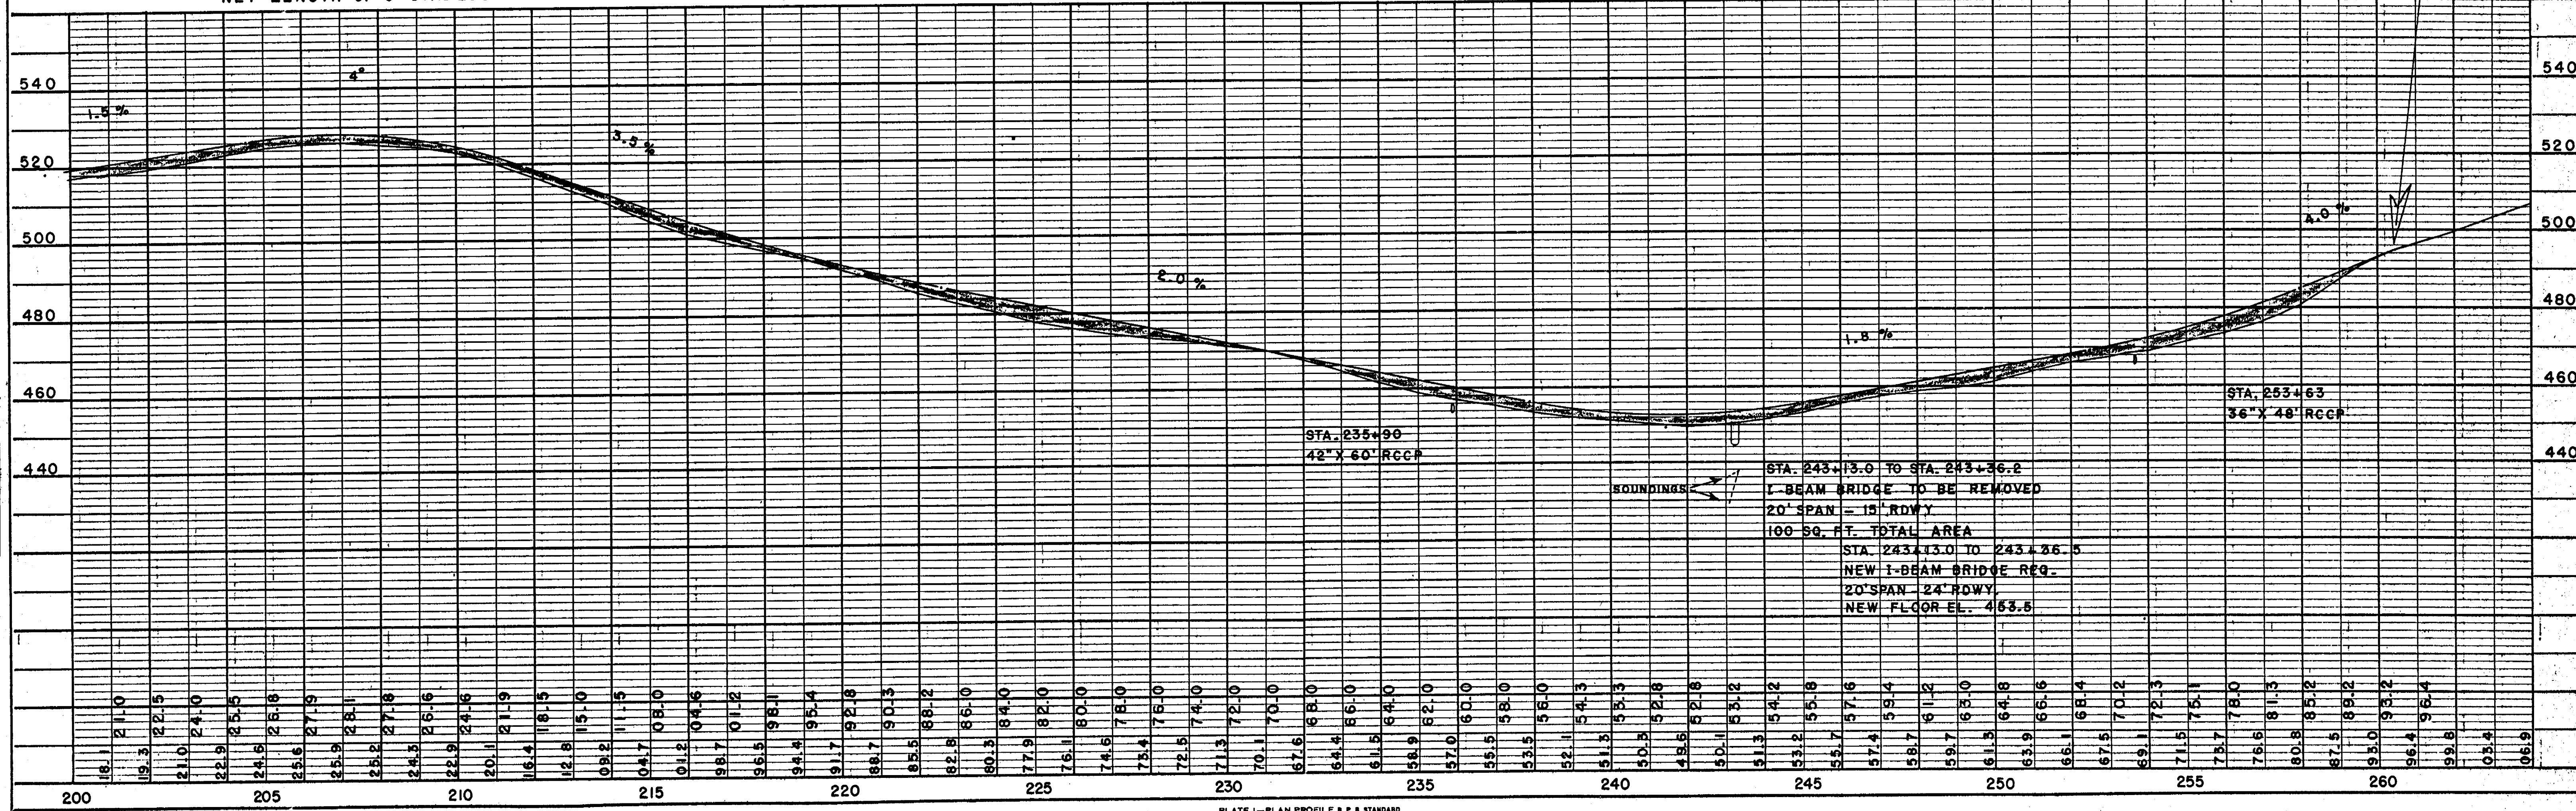

NOTE BOOK NO. 1000
ALIGNMENT CHECKED
RT. OF WAY CHECKED

NOTE BOOK NO. 1000
GRADES CHECKED
B.M.'S NOTED
STAKE PLACEMENTS CHECKED